STILLWATER COMMUNITY CENTER REROOFING RENOVATIONS & ALTERATIONS


BID DOCUMENTS JUNE 30, 2023

BUILDING INFORMATION:

	<u> </u>	
	Existing	Proposed
Use & Occupancy Classification Construction Classification	Mixed A-3 & S-2 Type 3B	No Change No Change
Building Hieght & Area Limitations:		Proposed
Building Height (FT) No. of Stories		No Cahnge No Change
Building Area (SF)		No Change

c Applicable Subcodes, as per the modifications of the New Jersey Uniform Construction Code:

New Jersey Rehabilitation Subcode, NJUCC Subchapter 6 International Building Code 2021 The National Standard Plumbing Code 2021

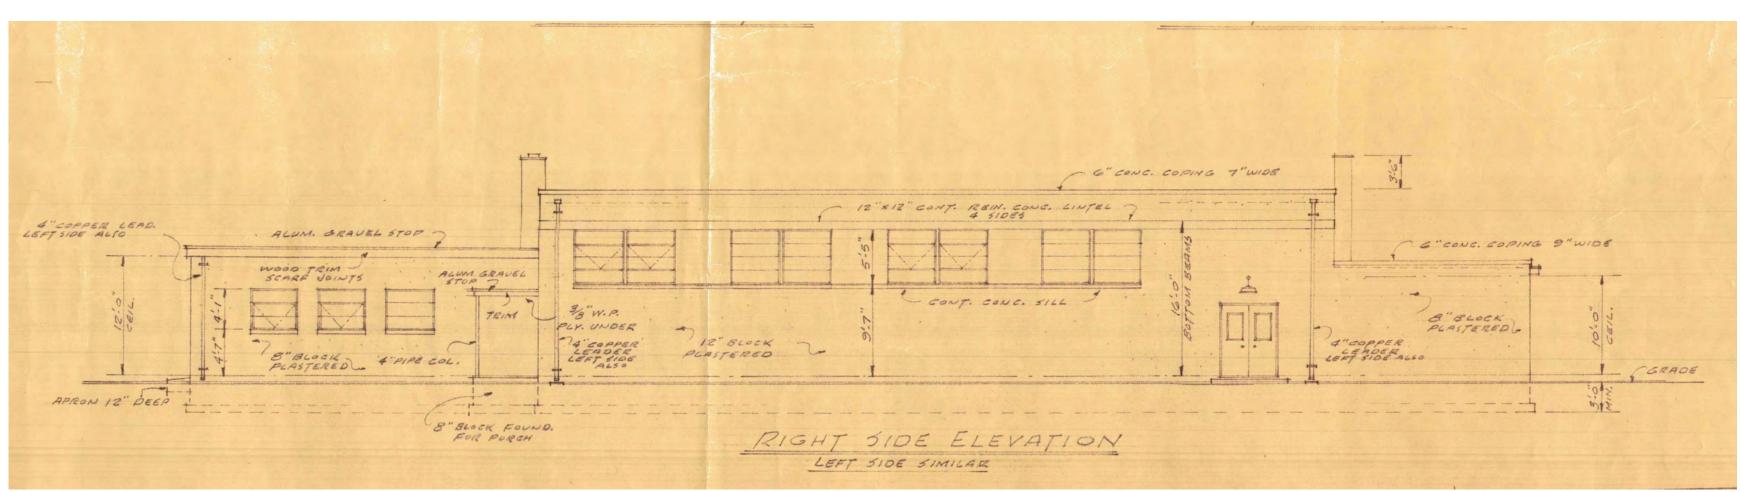

DRAWING LIST & DIRECTORY:

Drawings List & Project Directory **Building Subcodes &** Zoning Information

964 Stillwater Road Newton, NJ 07860 T: 973 383 9484

Owner: Stillwater Township

General Notes &


D-001

Architectural Plans: Selective Demolition Plan Soffit Framing Plan Reroofing Details

Samuel Ahren Wykoff, Architect LLC 996 County Road 521 Newton, NJ 07860 T: 973 383 9208

Reroofing Plan **Building & Soffit** Elevations

ORIGINAL 1953 RIGHT SIDE ELEVATION (FOR REFERENCE ONLY)

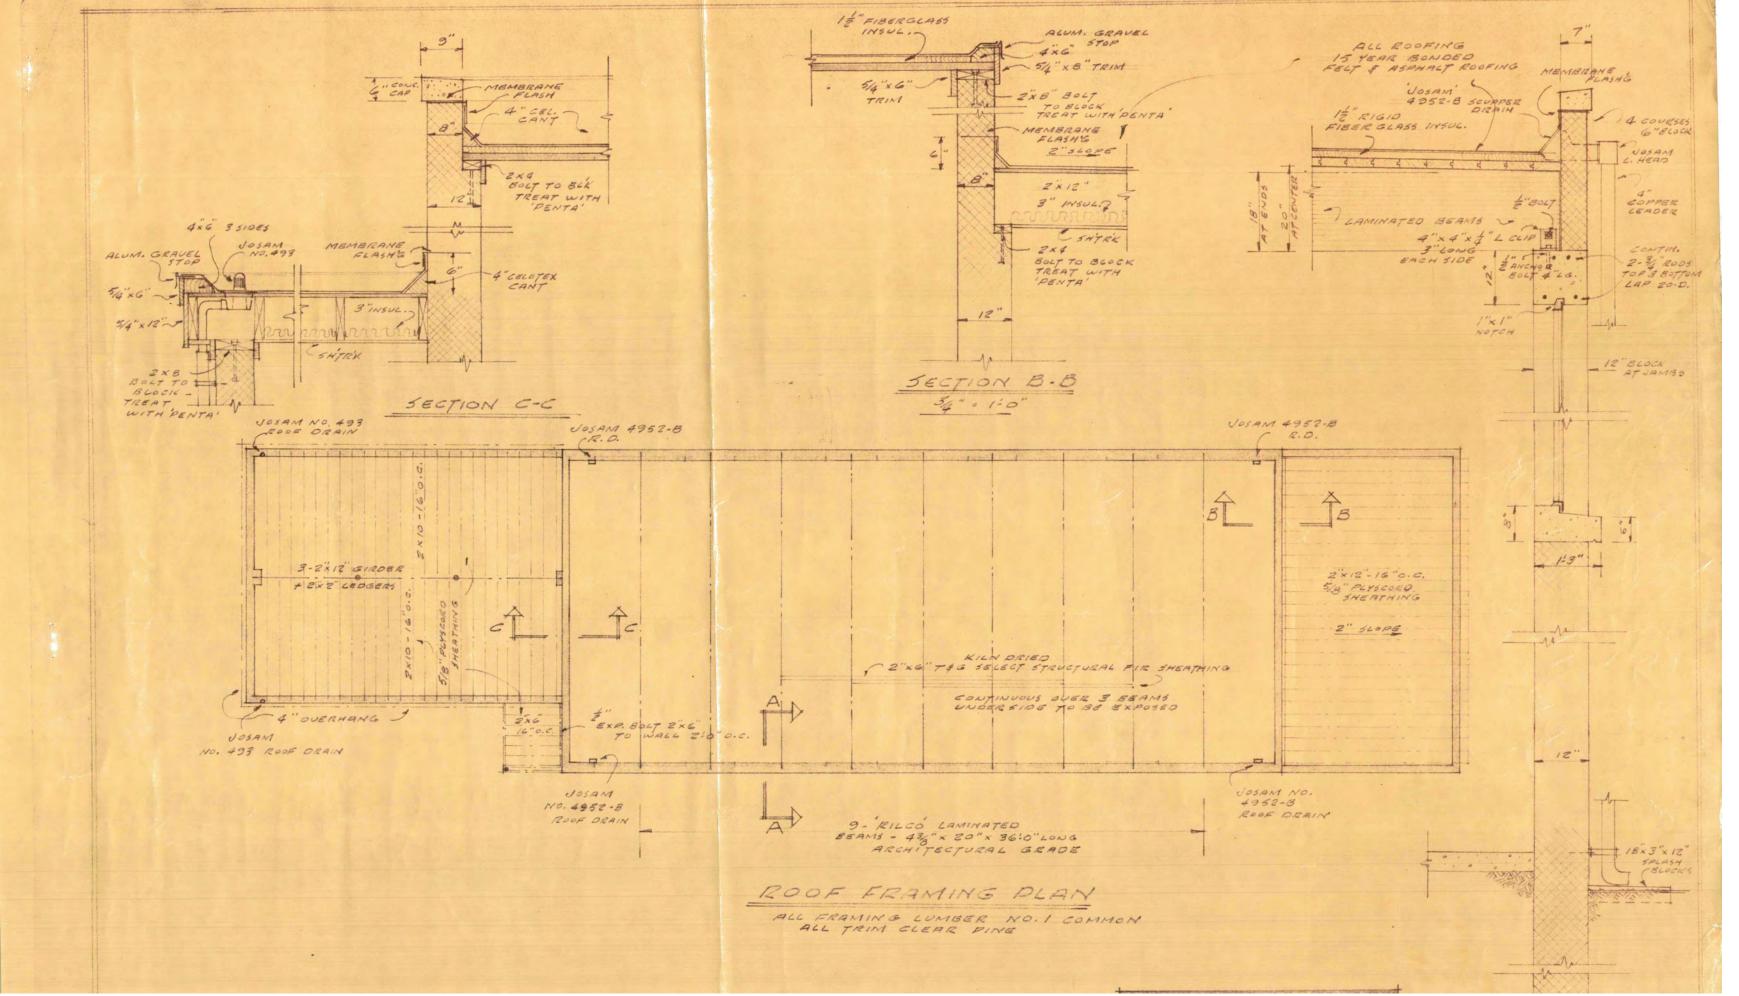

PROJECT DESCRIPTION:

This project consists of reroofing major portions of the Stillwater Township Community Center, including; soffit/eave demolition and construction, and associated minor electrical and mechanical work.

SITE & ZONING INFORMATION:

931 Swartswood Road, Newton, Sussex NJ NC Neihborhood Commercial Permitted Uses & Building Proposed Principal Uses Community Centers No Change **Bulk Requirements:** No Change Area (AC) No Change Width/Road Frontage (FT) Total Lot Coverage (%) No Change **Principal Buildings & Structures** Height (FT) No Change Setbacks (FT) Front Yard/Street/Lake No Change No Change Side Yard No Change Rear Yard/Street

ORIGINAL 1953 ROOF FRAMING PLAN & DETAILS (FOR REFERENCE ONLY)

Issue: Bid Documents Revised: Sheet Title: Project Directory & Drawings List

Building Subcodes & Zoning Info


Project ID: 2231 STCC

Issue Date: June 30, 2023

© 2023 Samuel Ahren Wykoff, Architect III

Samuel Ahren Wykoff

Project Description Sheet No:

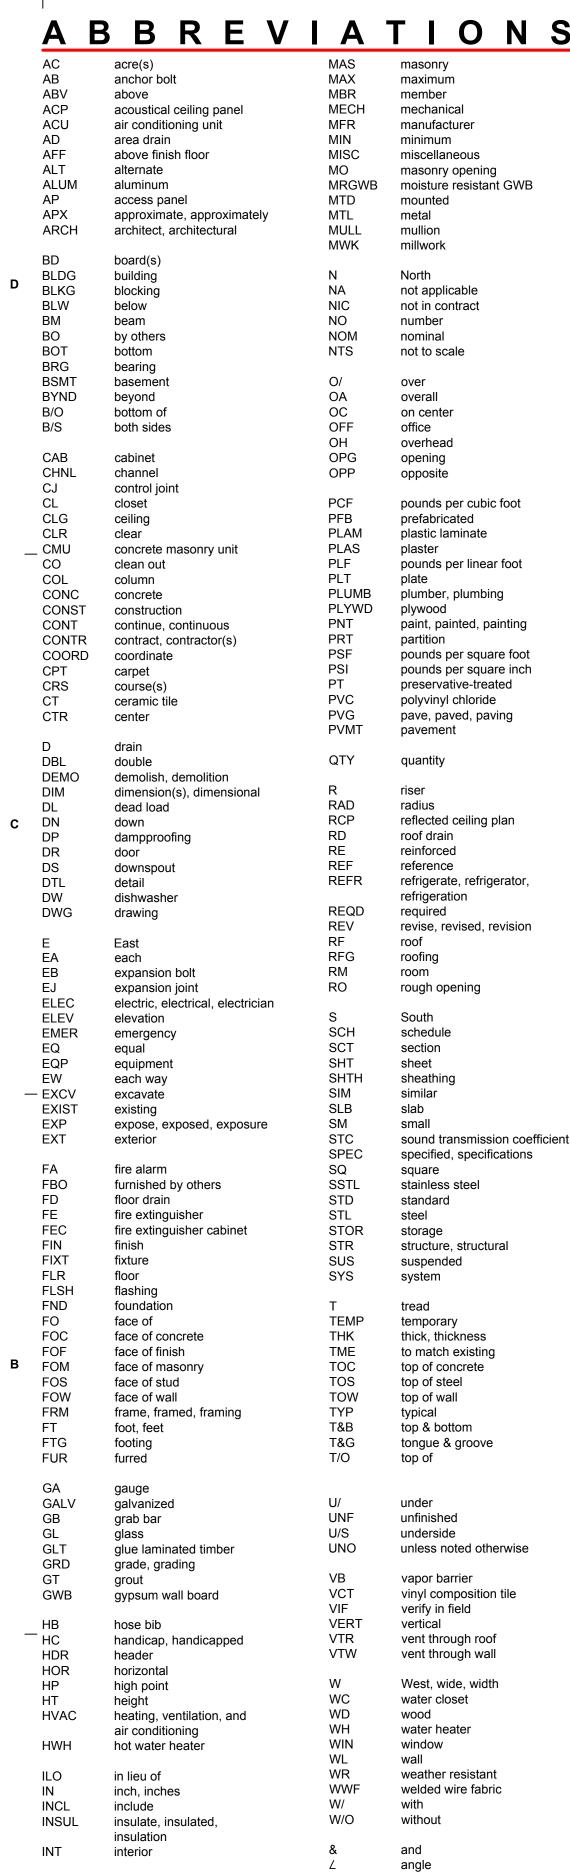

centerline

degrees

foot, feet

inch, inches

plus/minus (approximately)

diameter

number

percent

JNT

JST

LAV

LF

LG

LOA

LP

LT

LTL

LUM

LVL

joist

lavatory

lineal feet

live load

low point

light

lintel


lumber

length overall

laminated veneer lumber

large



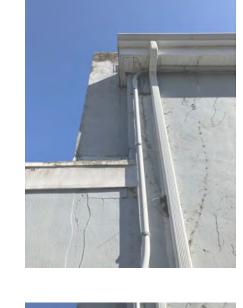









Drawing Number

Exterior Elevation

- Drawing Number

Interior Elevation

Drawing Sheet

2

NORTH

(PROJECT)

Elevation

- Drawing Sheet



/##\ — Revision Number

Reference Grid

Reference Row

Reference Column



Equipment, Fixture,

Furniture Number

- Keynote Number

Room Number



- Scale of materials varies throughout drawing set

Level Line, Control Point,

Hidden Line - Objects


Break/Match Line

Above/Behind



ENERAL GRAPHIC SYMBOLS

ROOM NAME

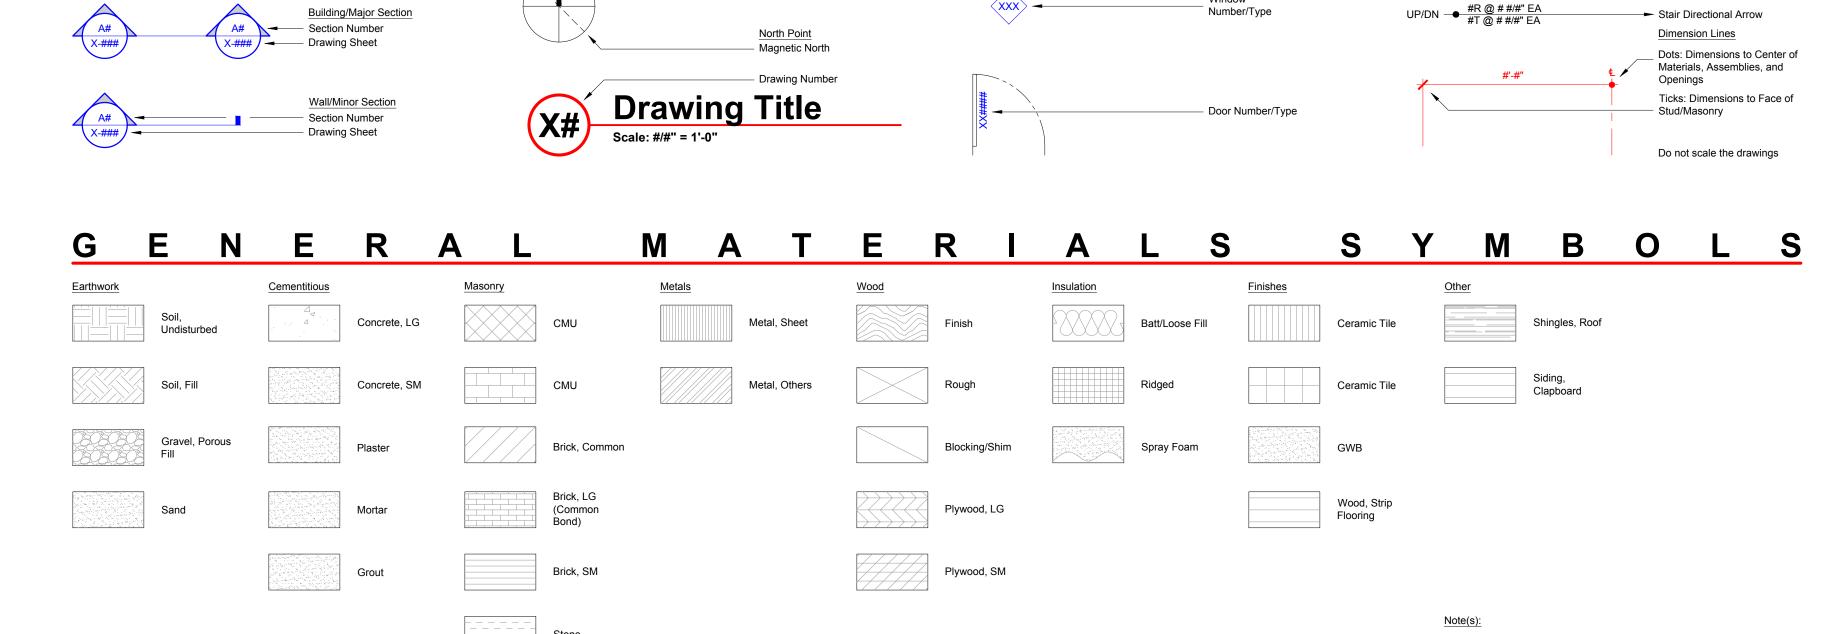

REHAB SUBCODE NOTES

1. The work shall not cause any diminution of existing structural strength below that which

- exists at the time of application for a permit or that which is required by the applicable subcodes of the Uniform Construction Code, whichever is lower.
 Construction materials used shall be consistent with the existing construction type or the
- Construction materials used shall be consistent with the existing construction type or tr allowable construction type, whichever is less restrictive.
- 3. Where a fireproofing material is removed that is integral to the rating of an existing fire-rated assembly, the material shall be replaced so that the rating is preserved.
- 4. When the work being performed creates or exposes wood framing of any wall, floor, ceiling, or roof, fireblocking shall be provided as required by the building subcode. The fireblocking material shall comply with the building subcode.
- 5. When work being performed creates or exposes the roof decking/sheathing or the framing of any wall, floor, ceiling, or roof assembly that is part of the building thermal envelope (encloses conditioned space), any accessible voids in insulation shall be filled using insulation meeting the R-values of the energy code. In the event that insulation meeting the R-values cannot be installed due to space constraints, insulation that fills the cavities of the framed assembly shall be installed.
- 6. Structural elements which are uncovered during the course of the rehabilitation and which are found to be unsound or otherwise structurally deficient, shall be reinforced, supported or replaced in accordance with the applicable structural design criteria of the building subcode.

GENERAL NOTES

- 1. Documents prepared by the Architect are instruments of the Architect's service for use solely with respect to this Project. The Architect retains all common law, statutory, and other reserved rights, including the copyright. The Owner, Contractor, subcontractors, sub-subcontractors, and suppliers are authorized to use and reproduce the instruments of service solely and exclusively for execution of the Work. The instruments of service may not be used for other Projects or for additions to this Project outside the scope of Work without the specific written consent of the Architect.
- 2. The Contractor shall visit the site, become familiar with local conditions under which the Work is to be performed, and correlate personal observations with requirements of the Construction Documents prior to proceeding with Work.
- 3. The Contractor shall carefully study and compare the Contract Documents with each other and with the information furnished by the Owner. Before commencing activities, the Contractor shall (1) take field measurements and verify field conditions; (2) carefully compare this and other information known to the Contractor with the Construction Documents; and (3) promptly report errors, inconsistencies, or omissions discovered to the Architect.
- 4. The Architect will not have control over or charge of, and will not be responsible for, construction means, methods, techniques, sequences, or procedures, or for safety precautions and programs in connection with the Work, since these are solely the Contractor's responsibility.
- 5. The Architect will not be responsible for the Contractor's failure to carry out the Work in accordance with the Construction Documents.
- 6. The Contractor shall be responsible for initiating, maintaining and supervising all safety precautions and programs, including all those required by law in connection with performance of the Work. The Contractor shall take reasonable precautions to prevent damage, injury, or loss to employees on the Work and other persons who may be affected thereby, the Work and materials and equipment to be incorporated therein, and other property at the site or adjacent thereto. The Contractor shall promptly remedy damage and loss to property caused in whole or in part by the Contractor, or by anyone for whose acts the Contractor may be liable.
- 7. To the fullest extent permitted by law, the Owner and Contractor shall indemnify and hold harmless the Architect from and against claims, damages, losses and expenses, including but not limited to attorneys' fees, arising out of or resulting from performance of the Work.

Project ID: 2231 STCC Issue Date: June 30, 2023 Issue: Bid Documents

Revised:

Sheet Title:

General Notes & Abbreviations Materials Symbols Reference Photographs Sheet No:

© 2023 Samuel Ahren Wykoff, Architect IIc

Samuel Ahren Wykoff

SELECTIVE DEMOLITION PLAN

Scale: 3/16" = 1'-0"

Project ID: 2231 STCC Issue Date: June 30, 2023 Issue: Bid Documents


Revised:

Sheet Title:

Selective Demolition Plan

© 2023 Samuel Ahren Wykoff, Architect IIc

Samuel Ahren Wykoff

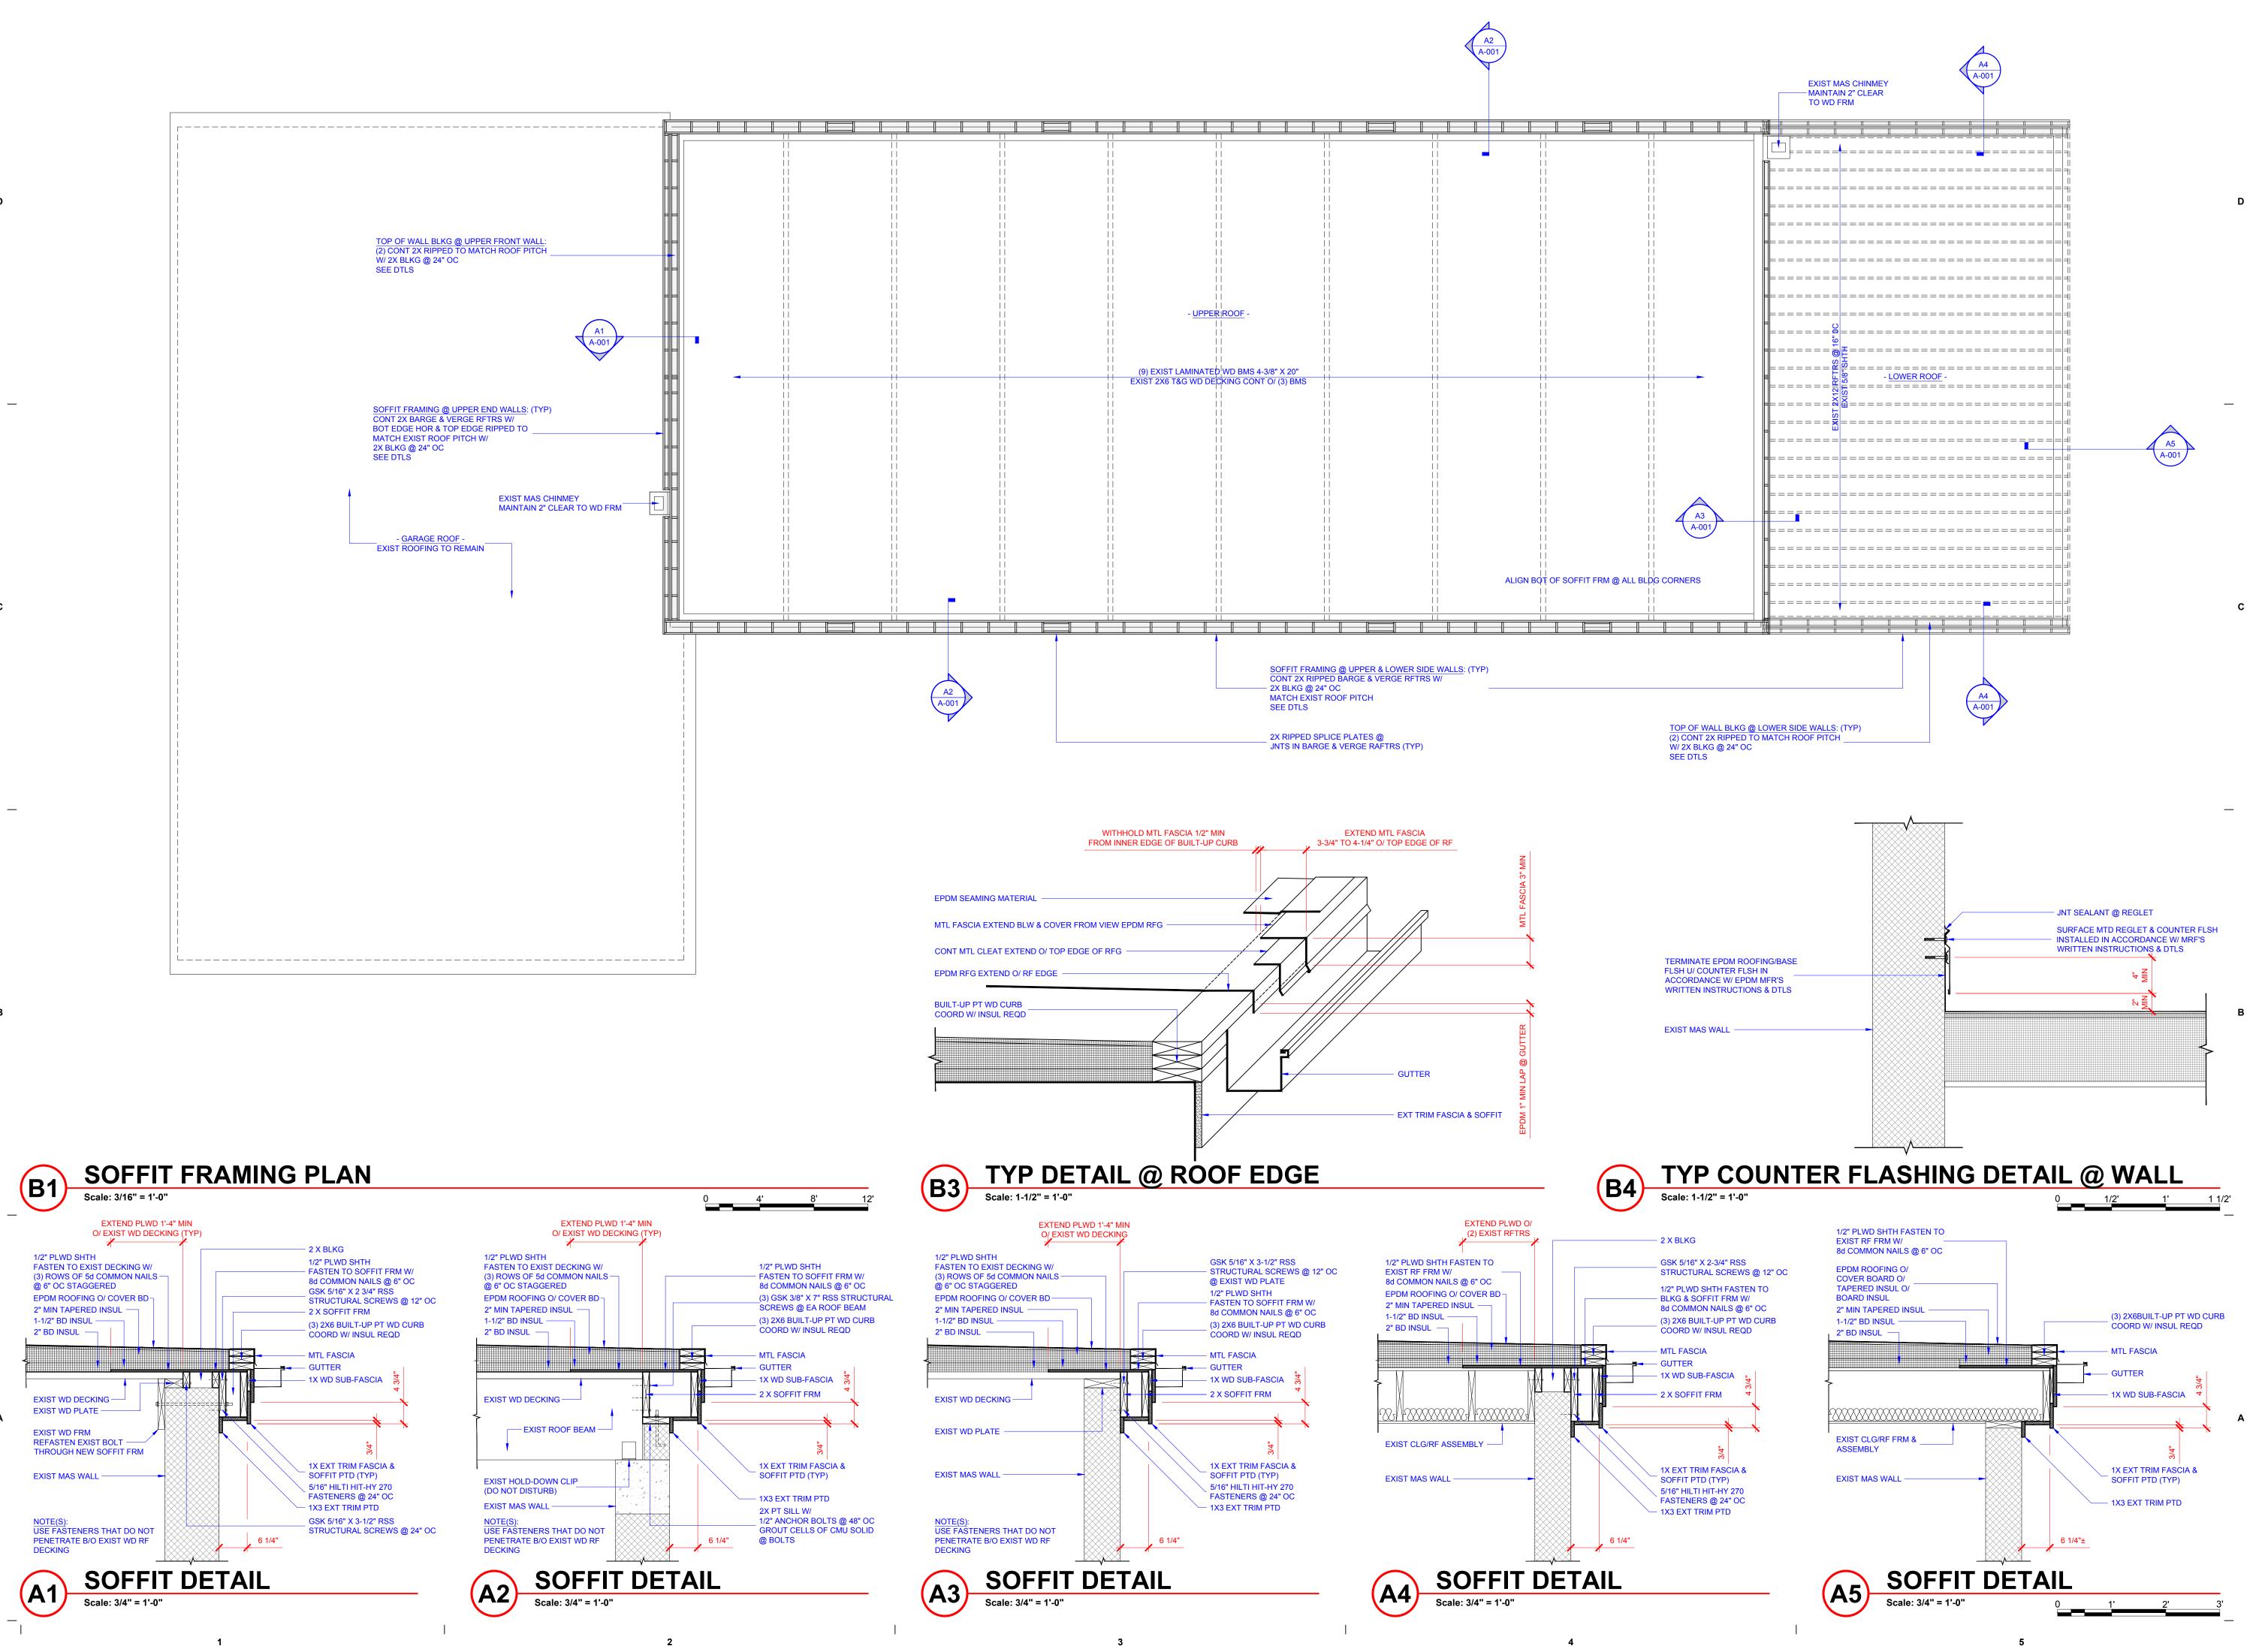

© 2023 Samuel Ahren Wykoff, Architect IIc

Samuel Ahren Wykoff

Project ID: 2231 STCC Issue Date: June 30, 2023 Issue: Bid Documents Revised:

Sheet Title: Soffit Framing Plan Reroofing Details

A - 0 0

© 2023 Samuel Ahren Wykoff, Architect IIc

Samuel Ahren Wykoff

Project ID: 2231 STCC Issue Date: June 30, 2023 Issue: Bid Documents

Reroofing Plan Building & Soffit Elevations

Revised:

Sheet Title: